

UNIVERSITY OF SOUTH CAROLINA BUILDING #1 CLASSROOM B1 AHU REPLACEMENT

COLUMBIA, SC H27-6111

A/E Project #15007.01

MARCH 30, 2015
ISSUED FOR CONSTRUCTION

Prepared by:



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ARCHITECTURAL

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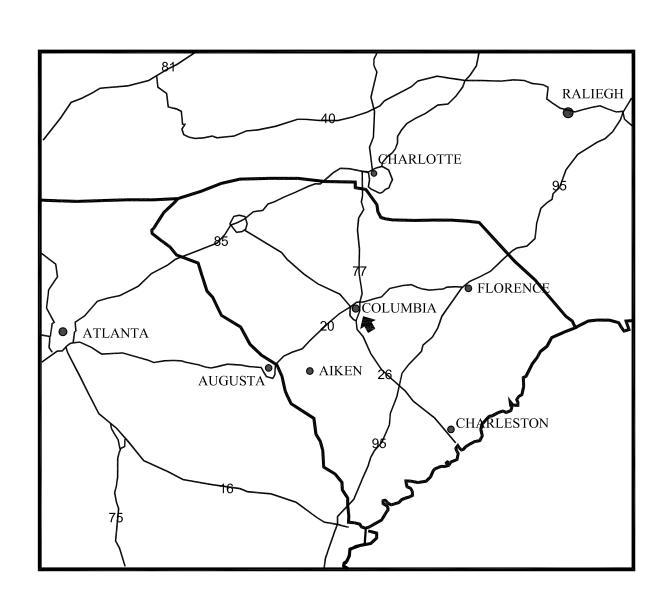
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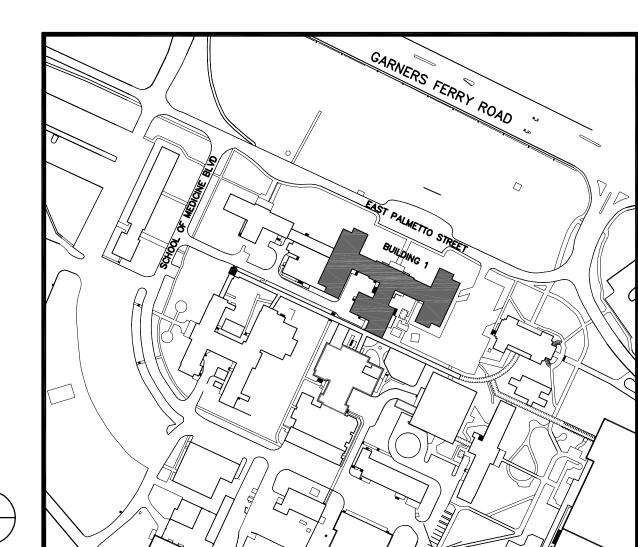
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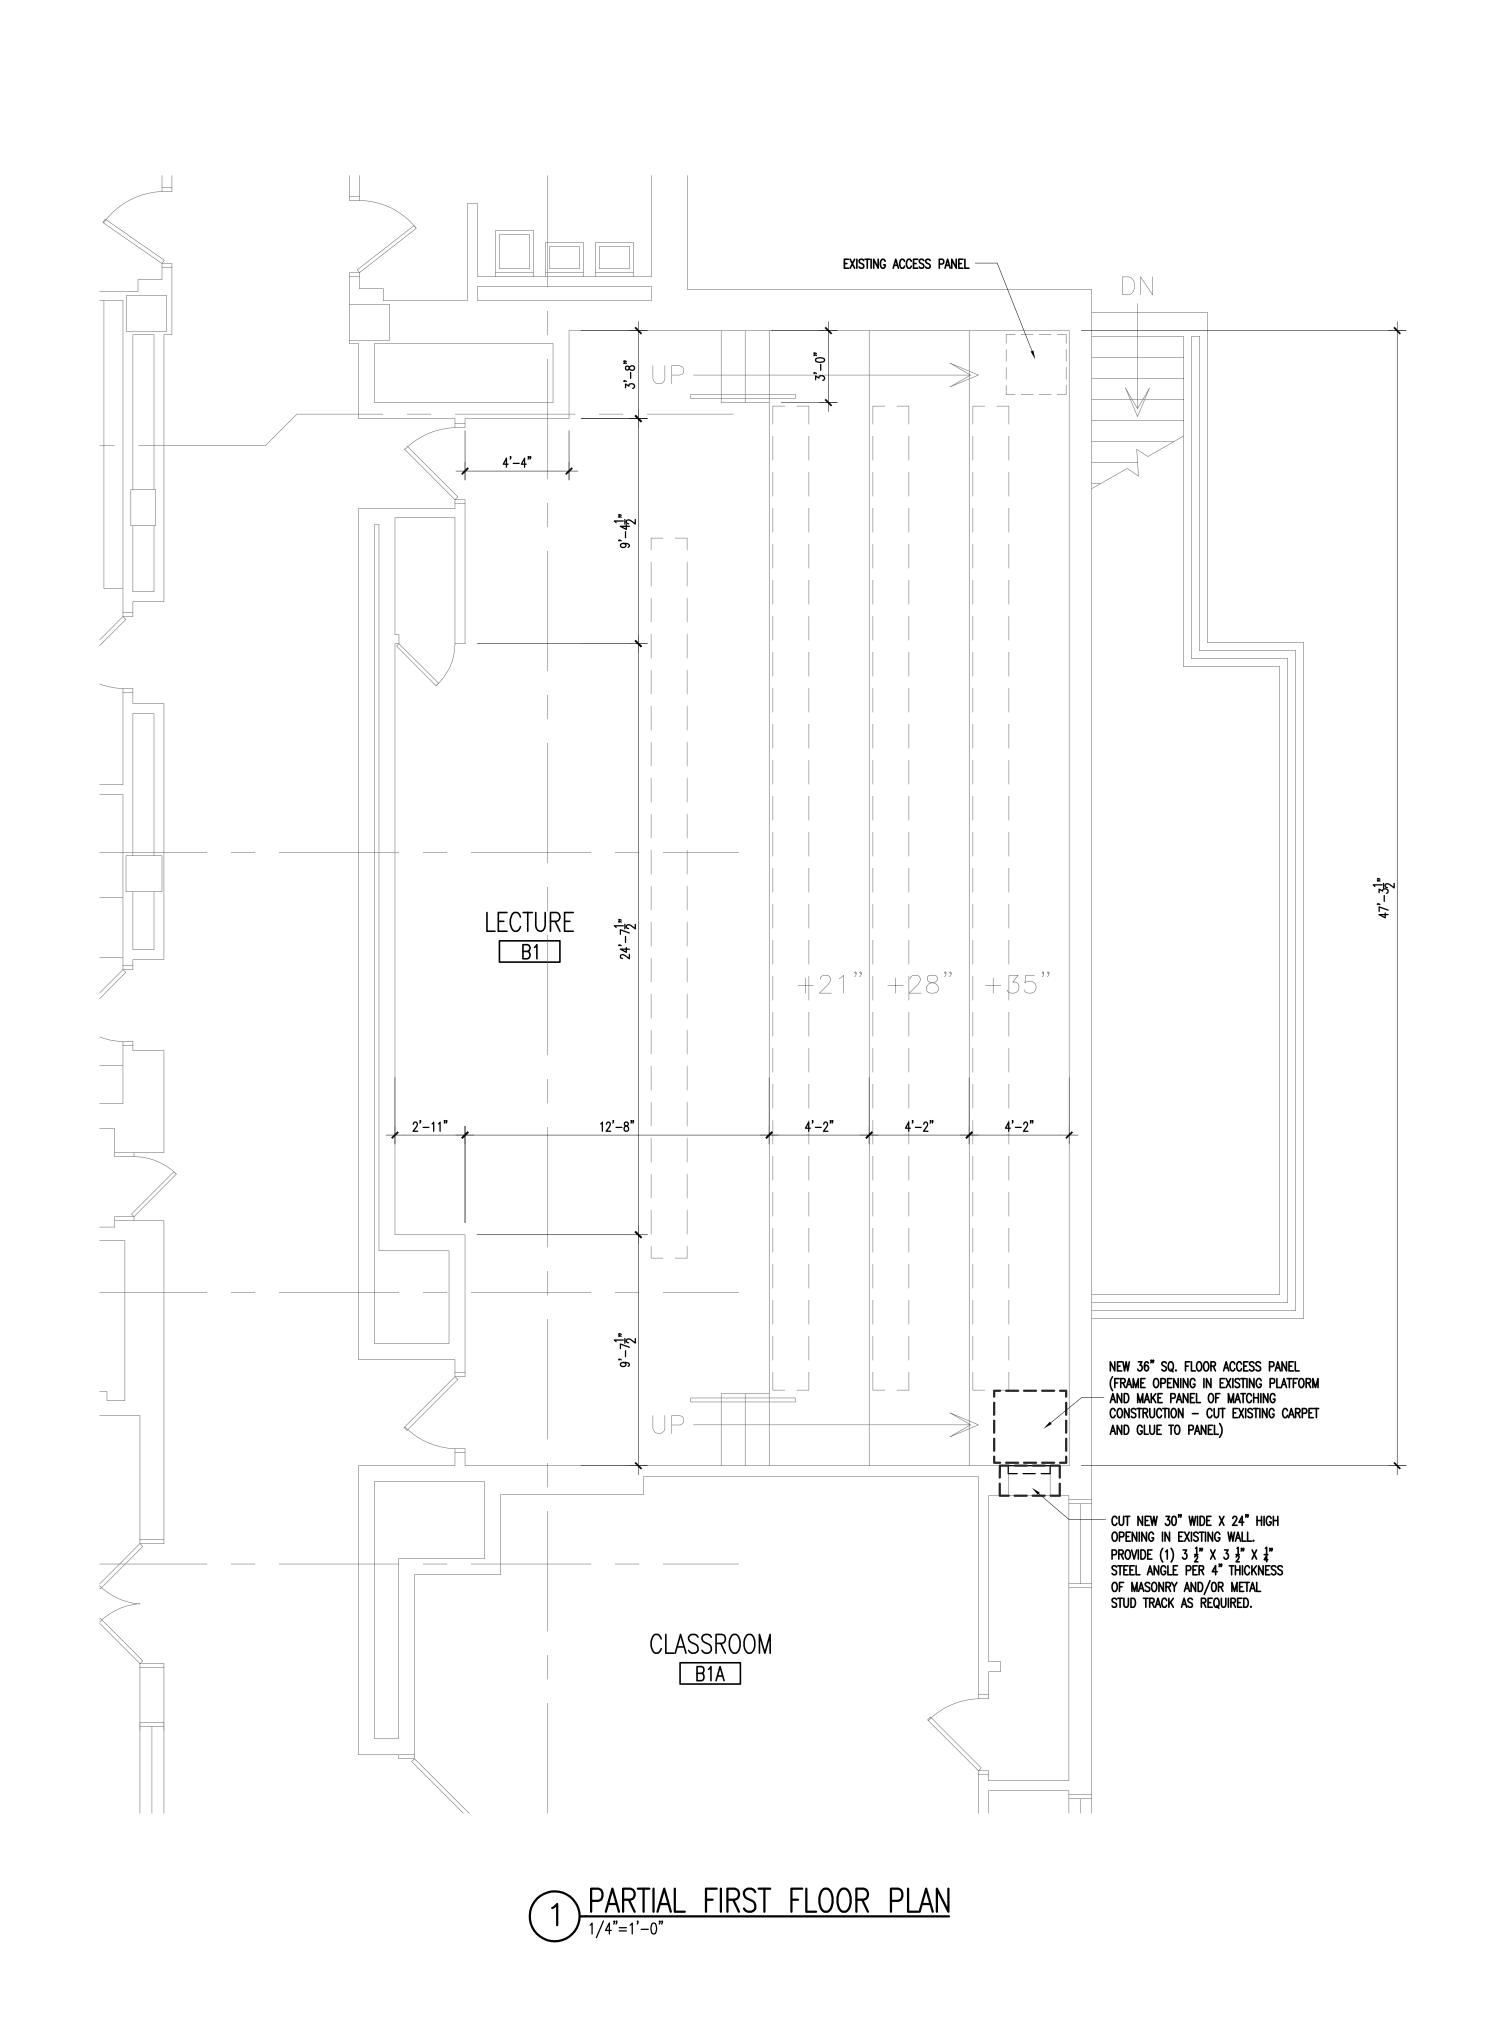
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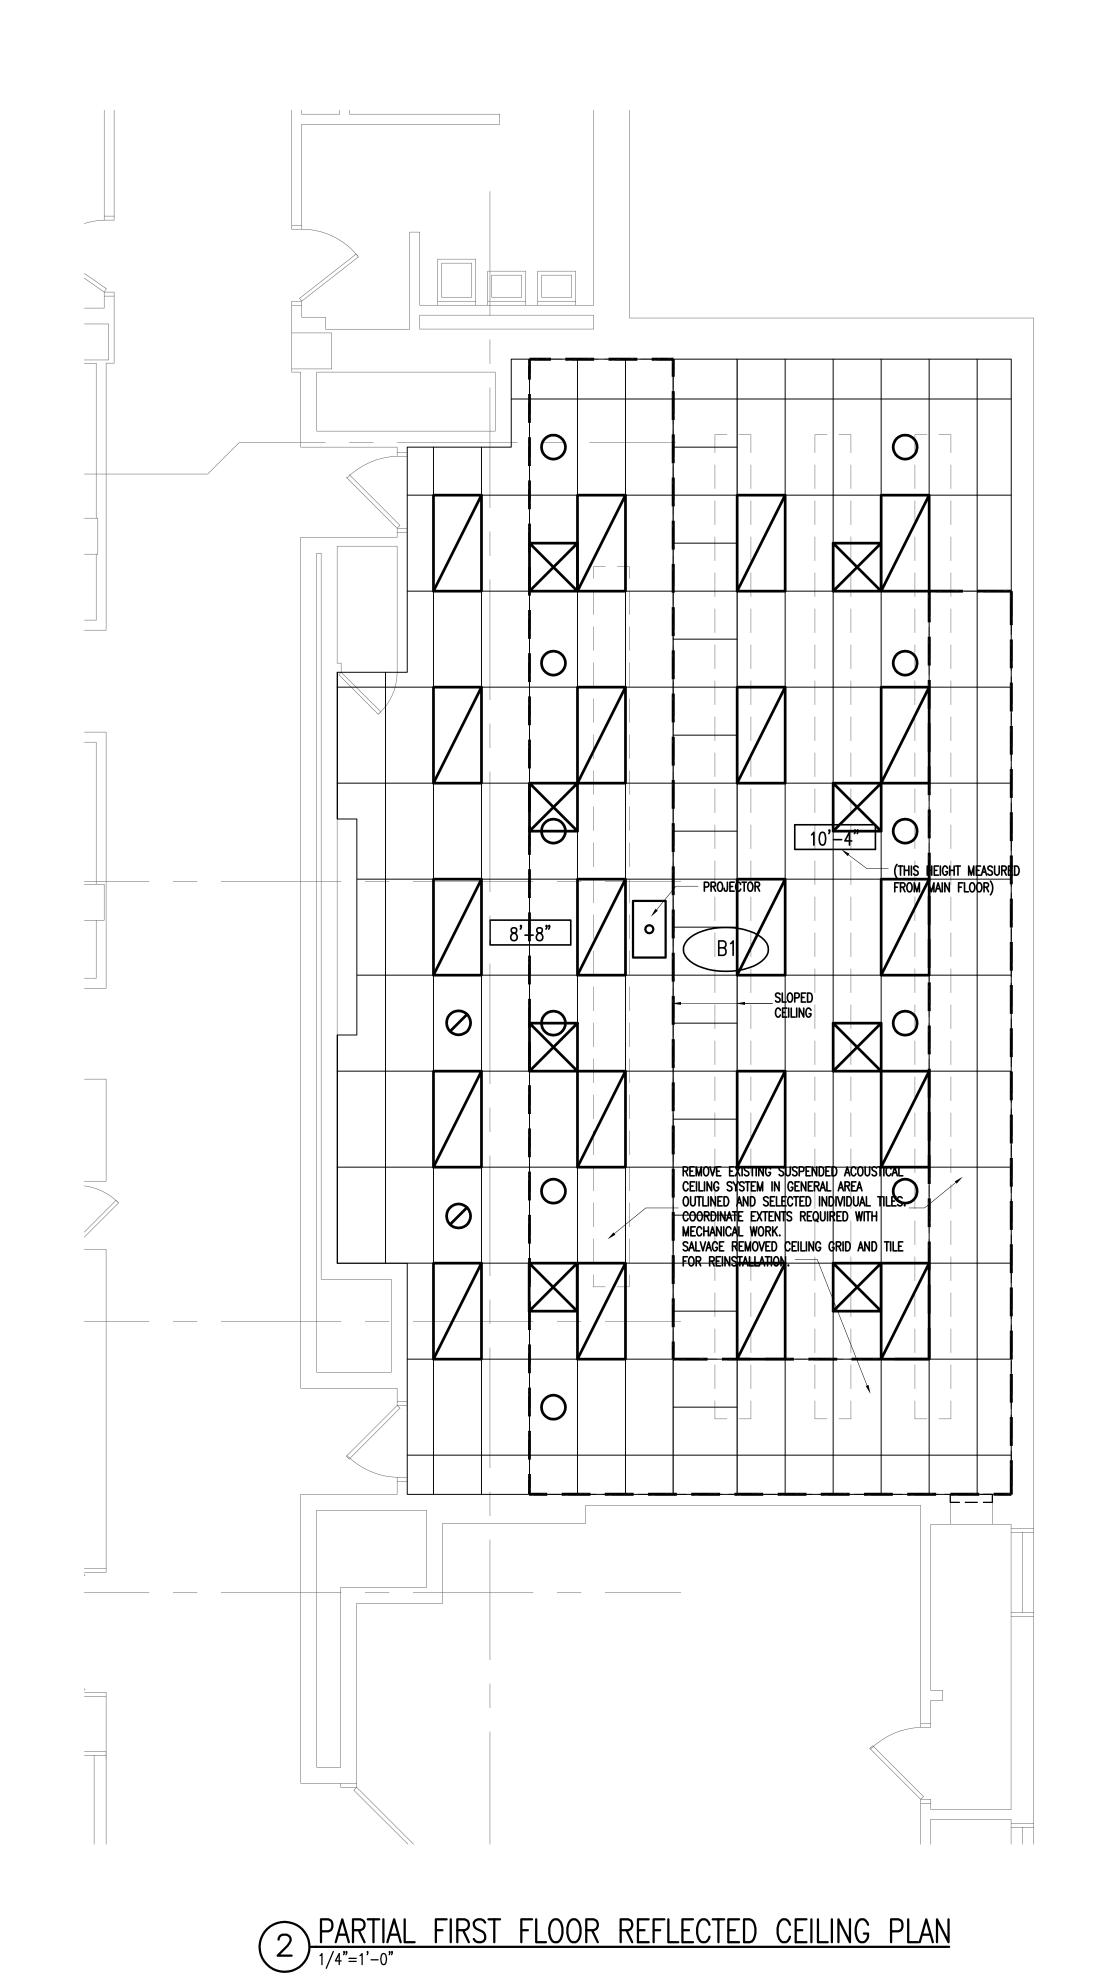
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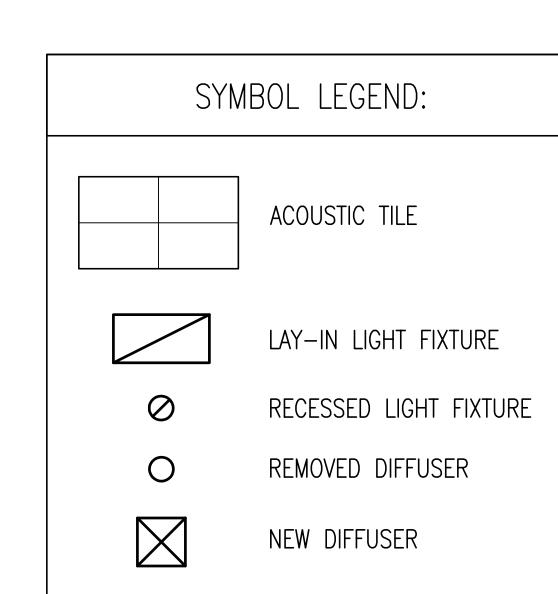
KEY PLAN











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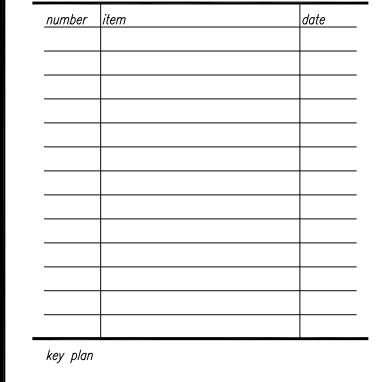
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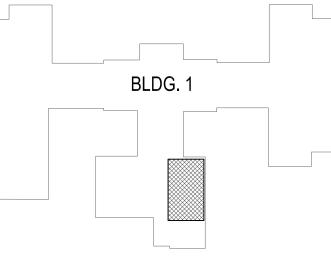
University of South Carolina
Building 1 Classroom B1
AHU Replacement State Project # H27-6111 A/E project number 15007.01

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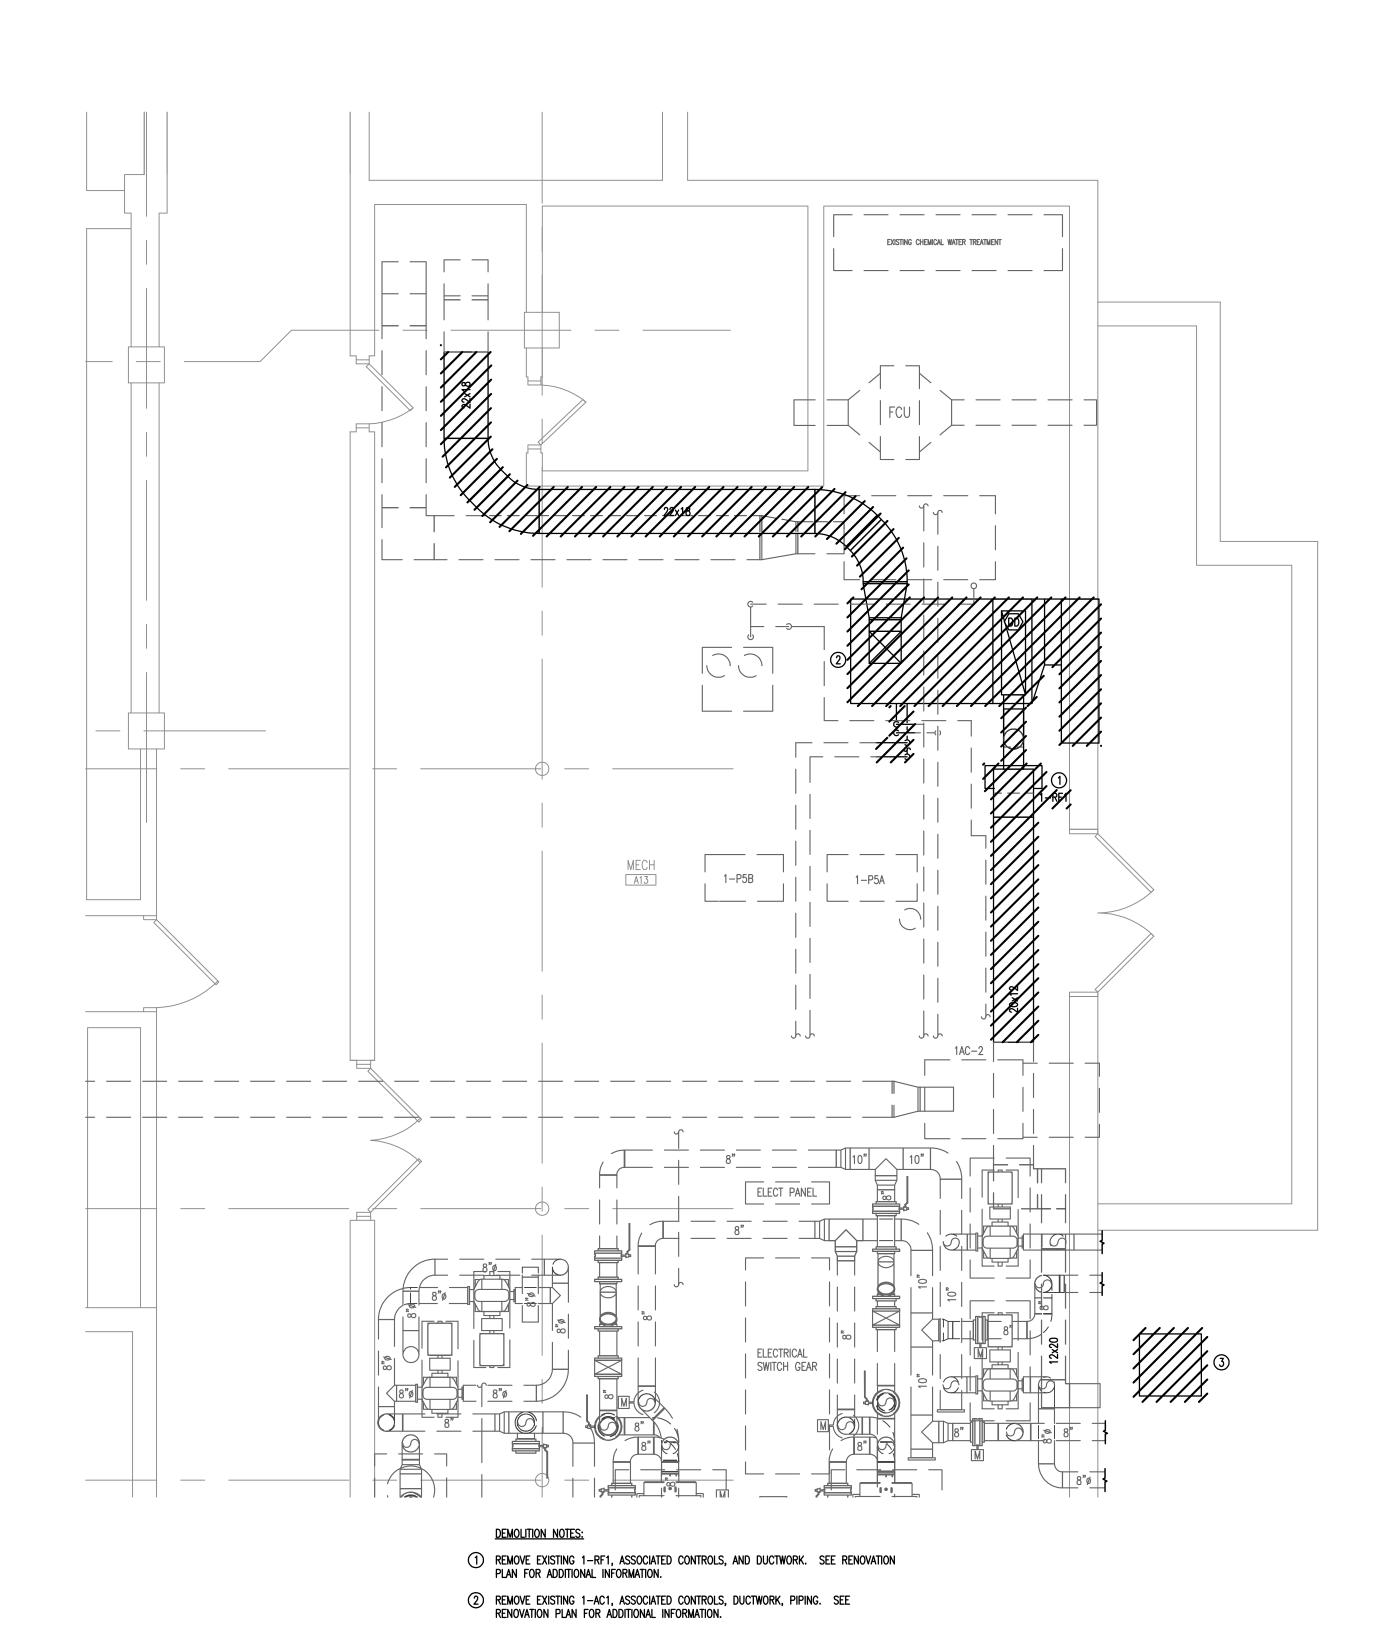




PARTIAL FIRST FLOOR AND REFLECTED CEILING PLANS


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3 REMOVE EXISTING CONDENSING UNIT (ON GRADE), ASSOCIATED, CONTROLS, AND PIPING.

1 PARTIAL BASEMENT FLOOR PLAN — HVAC DEMOLITION 1/4"=1'-0"



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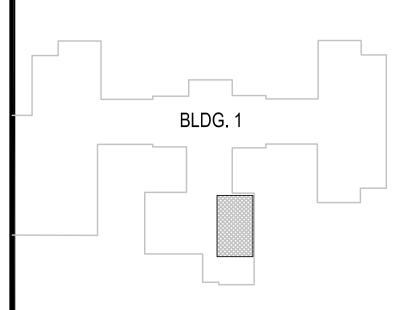
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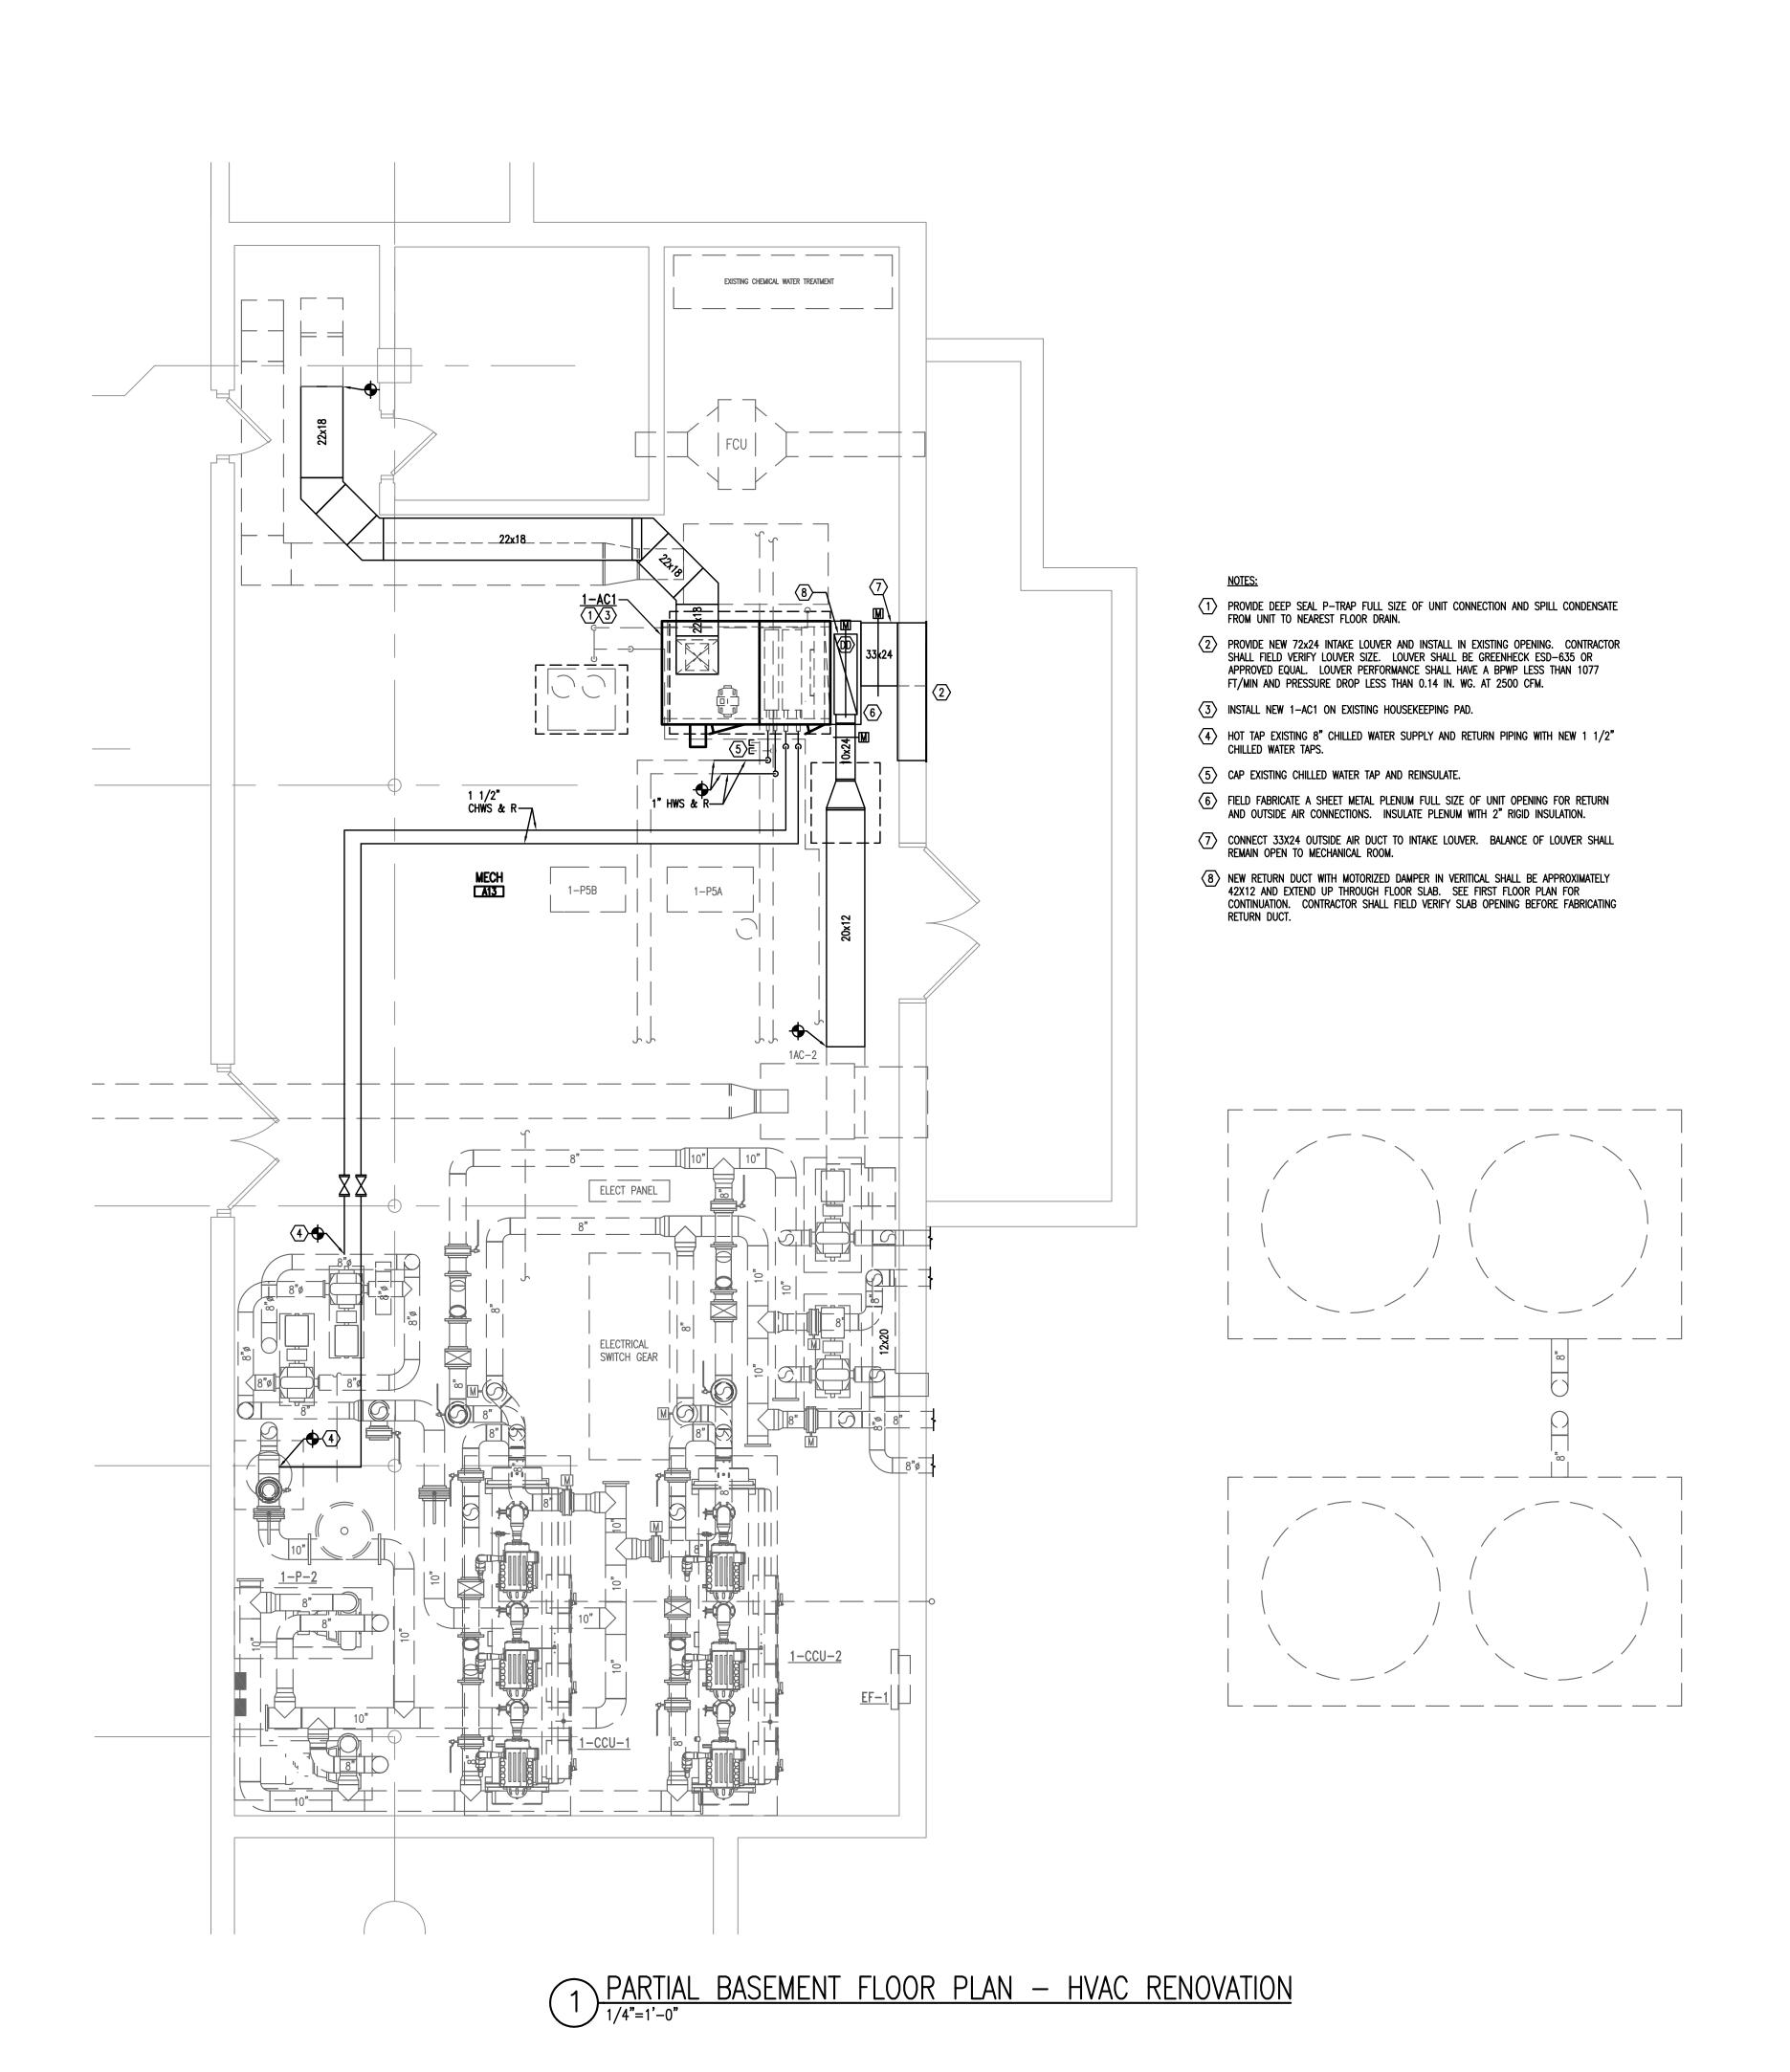


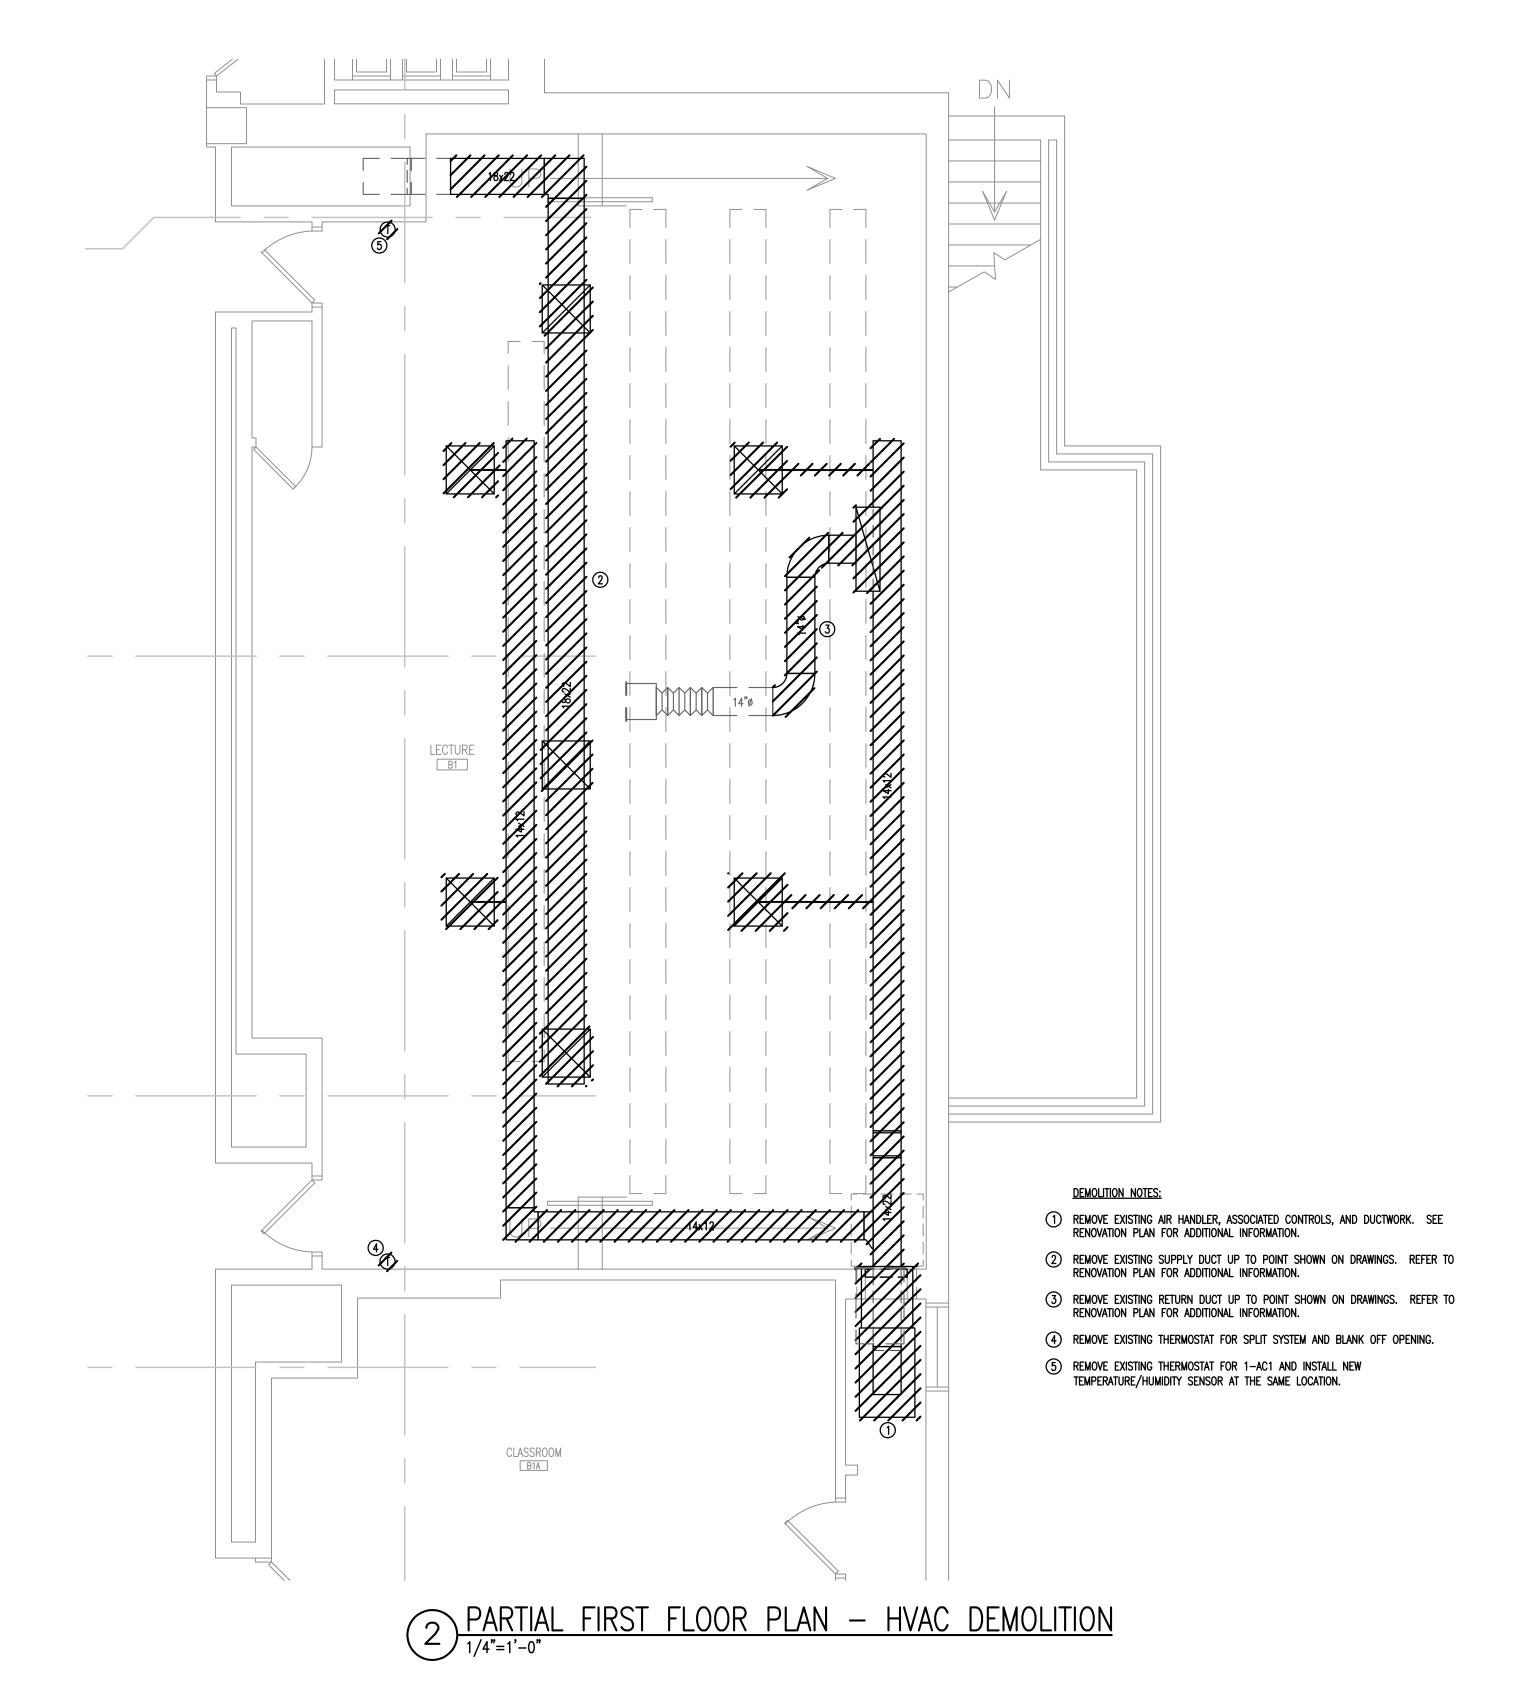


sheet title
PARTIAL BASEMENT AND FIRST
FLOOR PLAN - HVAC DEMOLITION

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2 PARTIAL FIRST FLOOR PLAN — HVAC RENOVATION 1/4"=1'-0"

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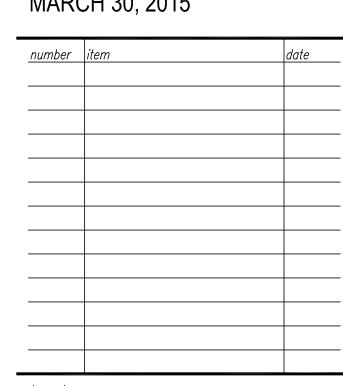
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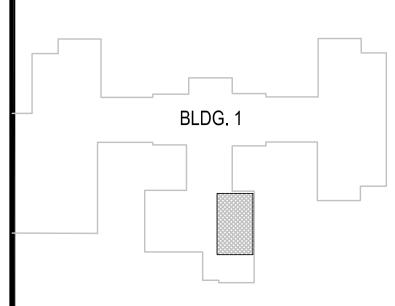
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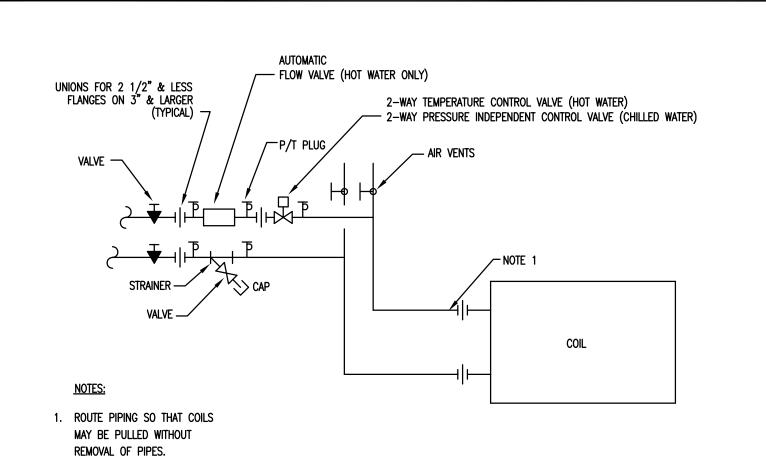


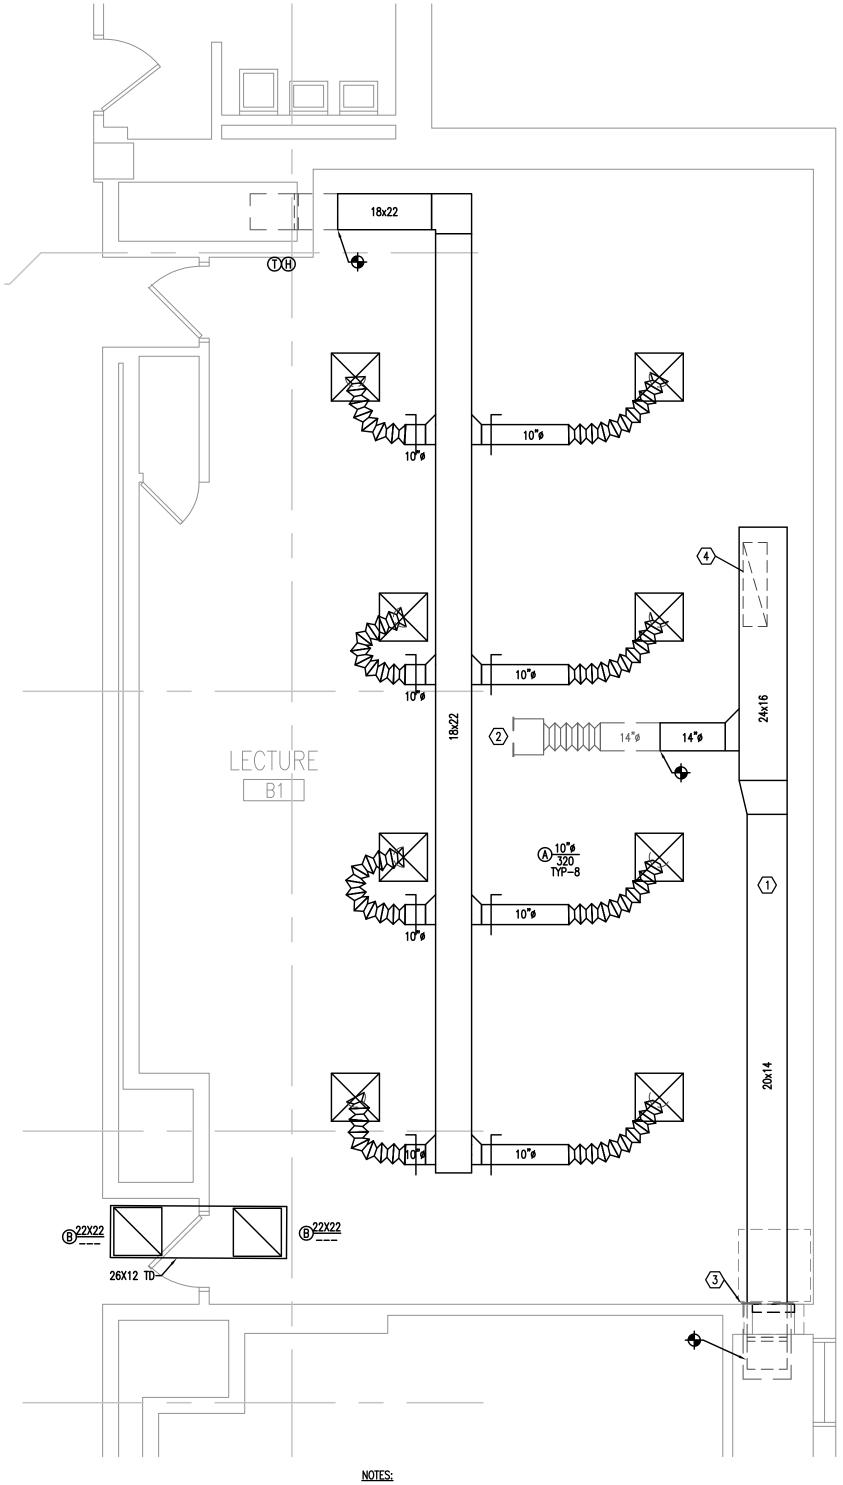


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PARTIAL BASEMENT AND FIRST
FLOOR PLAN - HVAC RENOVATION

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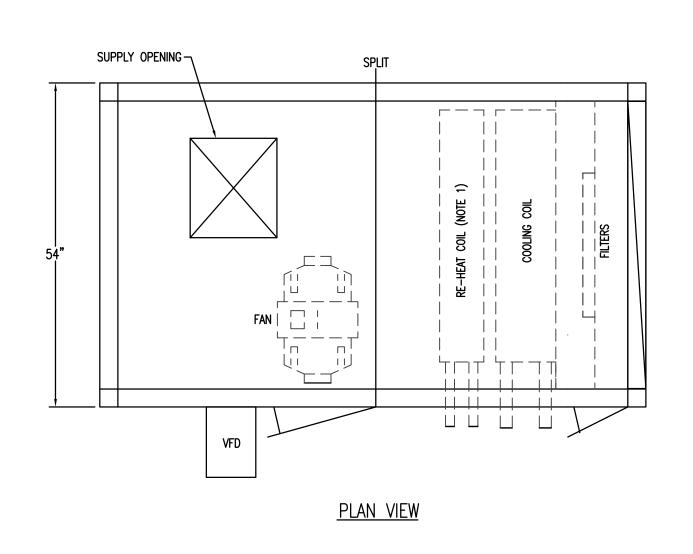



TWO WAY COIL PIPING DETAIL



(3) EQUIPMENT CONDENSATE DRAIN DETAIL

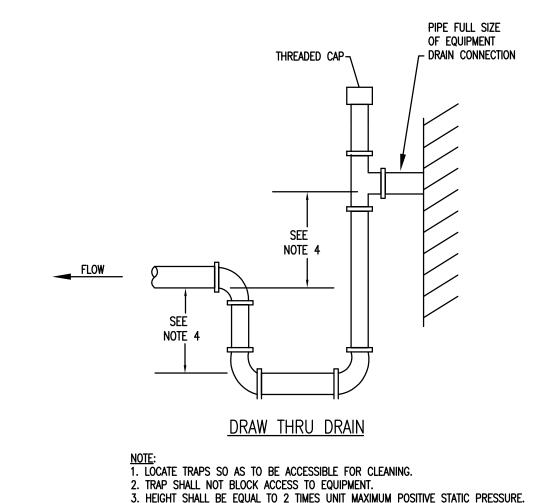4. HEIGHT SHALL BE DETERMINED BY THE EQUIPMENT MANUFACTURER.
5. PIPE TO NEAREST FLOOR DRAIN.



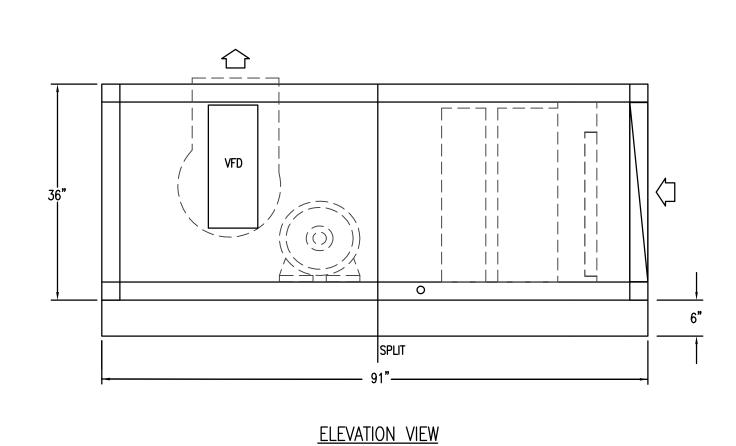

NOTES: 1. PROVIDE ACCESS DOORS AND COIL CONNECTIONS, AS SHOWN ABOVE. (ORIENTATION DETERMINED BY "FACING" DISCHARGE AIRFLOW).




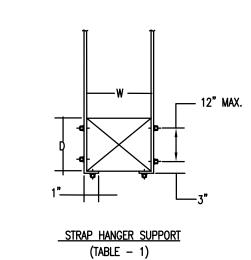



TABLE-1 STRAP HANGERS (PAIR) SPACED				
W + D MAX.	10'-0" MAX.	8'-0" MAX.	5'-0" OR LESS	
72 "	1" x 22Ga.	1" x 22Ga.	1" x 22G	
96"		1" x 20Ga.	1" x 22G	
120 "		1" x 18Ga.	1" x 22G	
168"			1" x 18G	
192"			1" x 16Go	

DUCT AND EQUIPMENT SUPPORT DETAILS

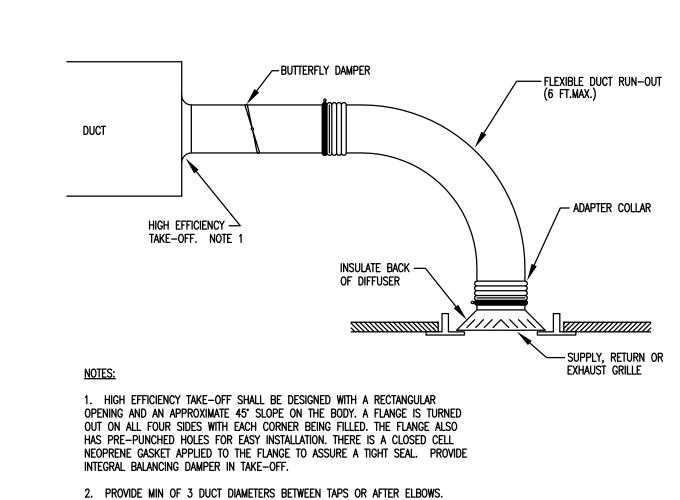

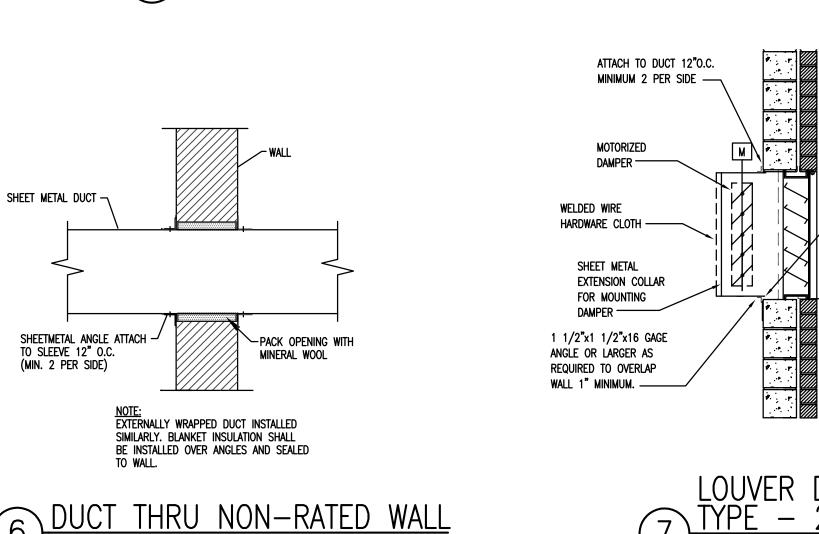

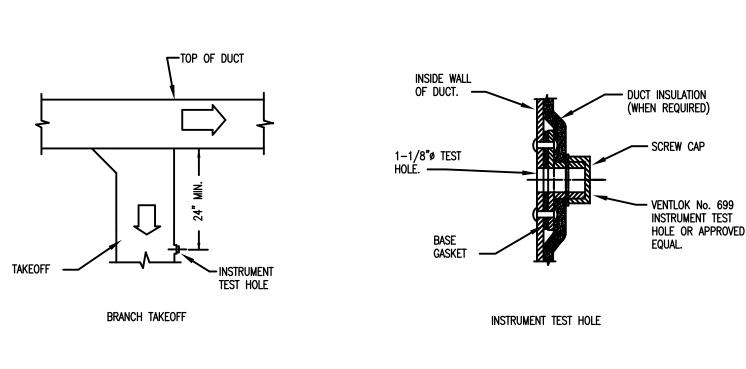

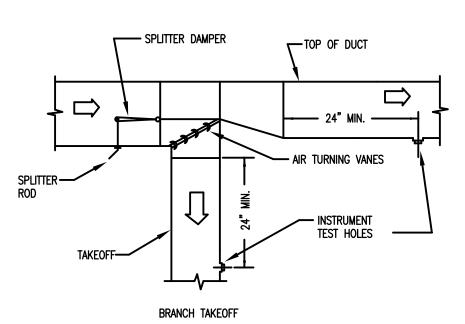

MECHANICAL DEMOLITION NOTES

- DRAWINGS SHOW GENERAL INTENT OF DEMOLITION. QUANTITIES, LOCATIONS, SIZES AND EQUIPMENT ARE SHOWN TO INDICATE TYPE OF SYSTEM INSTALLED AND DOES NOT NECESSARILY REPRESENT EXACT CONDITIONS. CONTRACTOR SHALL FIELD VERIFY BEFORE BIDDING.
- DEMOLITION OF EQUIPMENT, SYSTEMS, AND COMPONENTS SHALL INCLUDE ALL SUPPORTS, PADS, HANGERS, INSULATION, CONTROLS, STARTERS, ACCESSORIES, AND APPURTENANCES NOT REQUIRED FOR THE INSTALLATION OF THE NEW SYSTEM.
- WHEN PARTIAL DEMOLITION OF A SYSTEM IS INDICATED, THE PART OF THE SYSTEM SHOWN TO REMOVED SHALL BE REMOVED TO THE ACTIVE MAIN OR BRANCH IF NOT REQUIRED FOR THE INSTALLATION OF THE NEW SYSTEM. THE ACTIVE MAIN OR BRANCH SHALL BE REPAIRED TO MATCH NEW INSTALLATION AS MUCH AS PRACTICAL. IF SYSTEM IS INSULATED, INSULATION SHALL BE PATCHED AND FINISHED REPAIR (IE: VAPOR BARRIER, COATING, ETC.)
- 4. PATCHING OF BUILDING STRUCTURES AND FINISHES SHALL PERTAIN TO ALL WALLS, FLOORS, SLABS, ROOFS, STRUCTURES, AND FINISHES. PATCHES SHALL MATCH EXISTING STRUCTURE, FIRE RATING AND FINISH.
- 5, ALL OPENINGS CREATED BY THE ABANDONMENT OR REMOVAL OF EXISTING SYSTEMS SHALL BE PATCHED.
- 6. ALL WALLS, ROOFS, SLABS, STRUCTURES, AND FINISHES WHOSE FINISH IS IRREGULAR DUE TO THE REMOVAL OF SYSTEMS, SUPPORTS, PADS, ACCESSORIES,

UNTIL A SURFACE CHANGE OF A MINIMUM OF 45 DEGREES.

HVAC LEGEND

DIFFUSER, GRILLE, LOUVER——(A) 6"0 OR REGISTER TYPE

— SEAL ANULAR SPACE WITH

1. SEE ARCHITECTURAL

DRAWINGS FOR

LOUVER ELEVATIONS.

2. PROVIDE ADEQUATE SPACE

OUT STRIKING LOUVER

FOR DAMPER BLADES TO

OPERATE THRU 90° WITH-

NOTES:

SILICONE CAULK ALL AROUND

AND APPURTENANCES SHALL BE PATCHED. ALL FINISHES SHALL MATCH EXISTING FINISH. WHEN FINISH OBVIOUSLY DOES NOT MATCH EXISTING FINISH SUCH AS SHADE OF PAINT, AGE OF FINISH, ETC., THE

FINISH SHALL BE APPLIED TO THE PATCH AND THE SURFACE IN ALL DIRECTIONS

REMOVAL OF SYSTEMS SHALL INCLUDE COMPLETE SYSTEM WHENEVER PRACTICAL. IF NOT, SYSTEM (IE: PIPE, CONDUIT, ETC.) SHALL BE REMOVED TO 1 INCH BELOW

SUPPLY DIFFUSER

RETURN DIFFUSER

THERMOSTAT

DUCT SMOKE DETECTOR

RUN-OUT/FLEXIBLE DUCT

CHANGE IN DUCT ELEVATION

DUCT TURNING DOWN

DUCT TURNING UP

(DUCT RISE UNLESS SPECIFIED)

PEAK LOAD CFM

MECHANICAL GENERAL NOTES

- 1. DO NOT SCALE DRAWINGS; SEE ARCHITECTURAL DRAWINGS AND REFLECTED CEILING PLANS FOR EXACT LOCATIONS OF DOORS, WINDOWS, CEILING, DIFFUSERS, ETC. ALL DUCTWORK INSULATION SHALL BE RUN CONTINUOUSLY THROUGH FLOORS, ROOFS AND PARTITIONS EXCEPT WHERE PROHIBITED BY FIRE CODES.
- 3. LOCATE ALL THERMOSTATS 4'-0" ABOVE FINISH FLOOR; ALIGN WITH LIGHT SWITCHES.
- 6. AIR DISTRIBUTION SYSTEMS WITH MORE THAN ONE BRANCH, OR MULTIPLE OUTLETS ON A BRANCH, SHALL HAVE VOLUME DAMPERS TO BALANCE AIR FLOWS. SPIN-IN FITTINGS ARE PERMITTED FOR CONNECTING FLEX DUCT TO BRANCH OR TRUNK DUCTS WHERE FLEX DUCTS ARE INDICATED. IF FLEX DUCT CANNOT BE CONNECTED WITH A SPIN-IN, A HARD DUCTED TAKEOFF MUST BE PROVIDED.

ABBREVIATIONS						
Air Conditioning Above Above Finished Floor Brake Horsepower Cubic Feet Per Minute Duct Smoke Detector Dry Bulb Temperature Entering Air Temperature Electric or Electrical Entering Air Wet Bulb Exhaust Fire Damper Floor	N/A NIC NTS OBD OD PD RA RET RH SAHT SP SPEC SPI	Not Applicable Not in Contract Not To Scale Opposed Blade Damper Outside Diameter Pressure Drop Return Air Return Relative Humidity Supply Air Sheet Static Pressure Specifications Supply				
Horsenower	SPL	Supply				

MAX NC. MODEL

APDDR

PRESS DROP NO. OF (FT. WATER) FINS/IN.

TEMPERATURE
— SENSOR

SUPPLY AIR
TEMPERATURE

35

MFGR

PRICE

160 11.4

MANUFACTURER

180

ACCESSORIES

Leaving Air Temperature

Leaving Air Wet Bulb

AIR DISTRIBUTION SCHEDULE

NECK MODULE MOUNT CONSTR.

AS SHOWN 24 X 24 LAY-IN ALUMINUM

AS SHOWN 24 X 24 LAY-IN ALUMINUM

75.8 66.4 52.9 52.2 44

Prefilters Type

COOLING COIL

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NOTES

REMARKS

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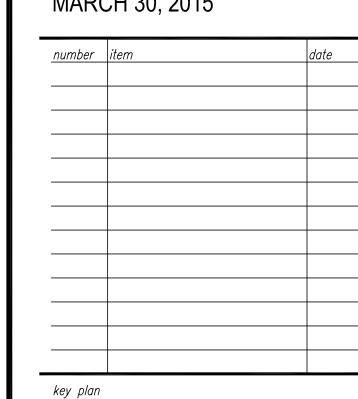
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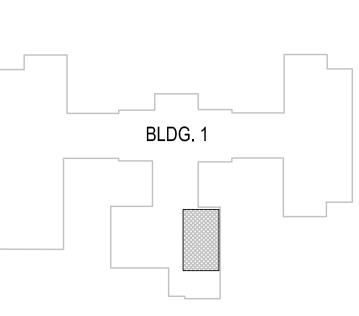
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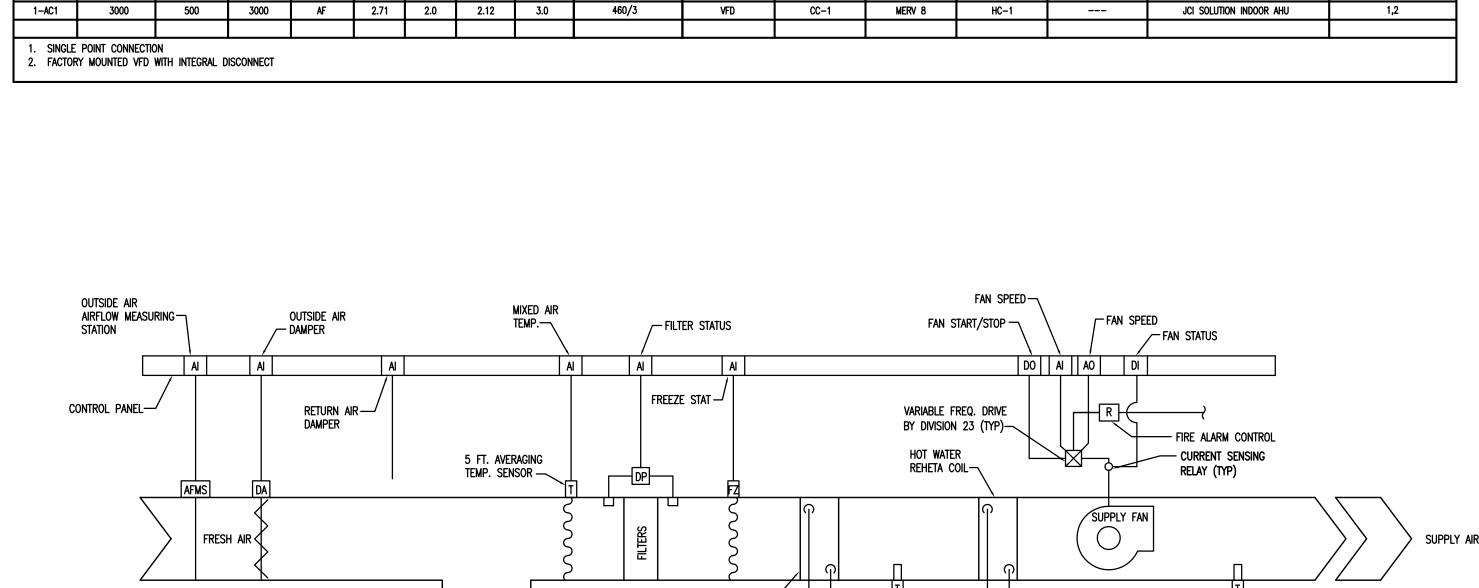


HVAC LEGENDS, NOTES, ABBREVIATIONS, SCHEDULES AND DETAILS


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CHILLED WATER —/ COOLING COIL



8 TYPICAL LOW PRESSURE DUCT DETAILS

DESCRIPTION

NOTES: 1. FURNISH WITH OBD

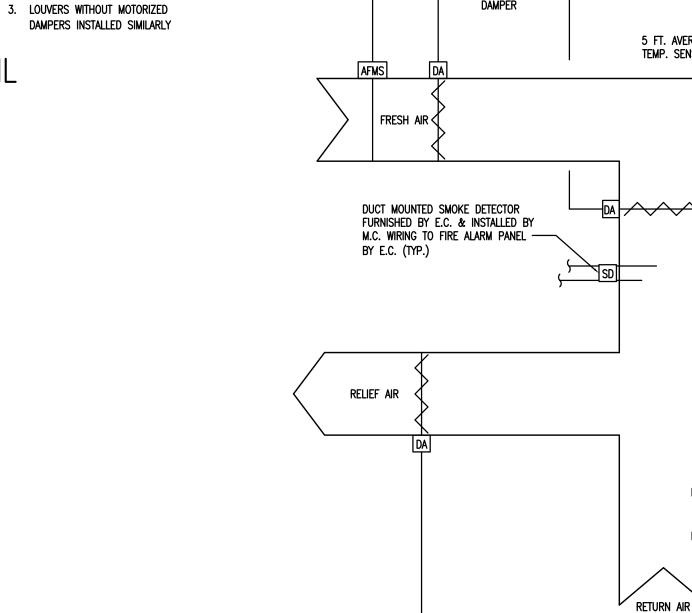PERFORATED CEILING SUPPLY

PERFORATED CEILING RETURN/EXHAUST

3. FURNISH WITH INSULATED BOOT PLENUM 4. BAKED ENAMEL OFF—WHITE FINISH

5. HEAVY DUTY GRILLE 6. FACTORY INSULATED BACK PAN

110.8

VOLTS/PHASE

AIR HANDLER UNIT SCHEDULE

VOLUME CONTROL

2. 4-WAY DEFLECTION (UNLESS OTHERWISE NOTED)

COIL SCHEDULE

4. ALL DUCTWORK LOCATIONS SHALL BE COORDINATED WITH THE WORK UNDER OTHER DIVISIONS OF THE SPECIFICATIONS TO AVOID INTERFERENCE.

5. CORRECT SETTINGS ON ALL BALANCING FITTINGS SHALL BE PERMANENTLY MARKED.

7. HIGH EFFICIENCY TAKEOFFS SHALL BE USED ON ALL HARD DUCTED SUPPLY

8. PROVIDE ALL TRANSITIONS REQUIRED FOR INSTALLATION OF DUCT, EXHAUST FANS, AND ALL OTHER EQUIPMENT AND APPURTENANCES.

9. ALL DUCT IS GALVANIZED SHEET METAL EXCEPT AS NOTED.

VELOCITY (FPM)

1-AC1

1-AC1

SP (IN. W.G.)

return duct — Humidity

return air —

TEMPERATURE

9 1-AC1 CONTROL SCHEMATIC

10. DUCT SIZES ARE CLEAR INSIDE DIMENSIONS. 11. AIR DISTRIBUTION UNITS SHALL HAVE TRIM REQUIRED FOR FINISHED SERVICE.

